


B1297000-PH2/3000.01a/0006 C3

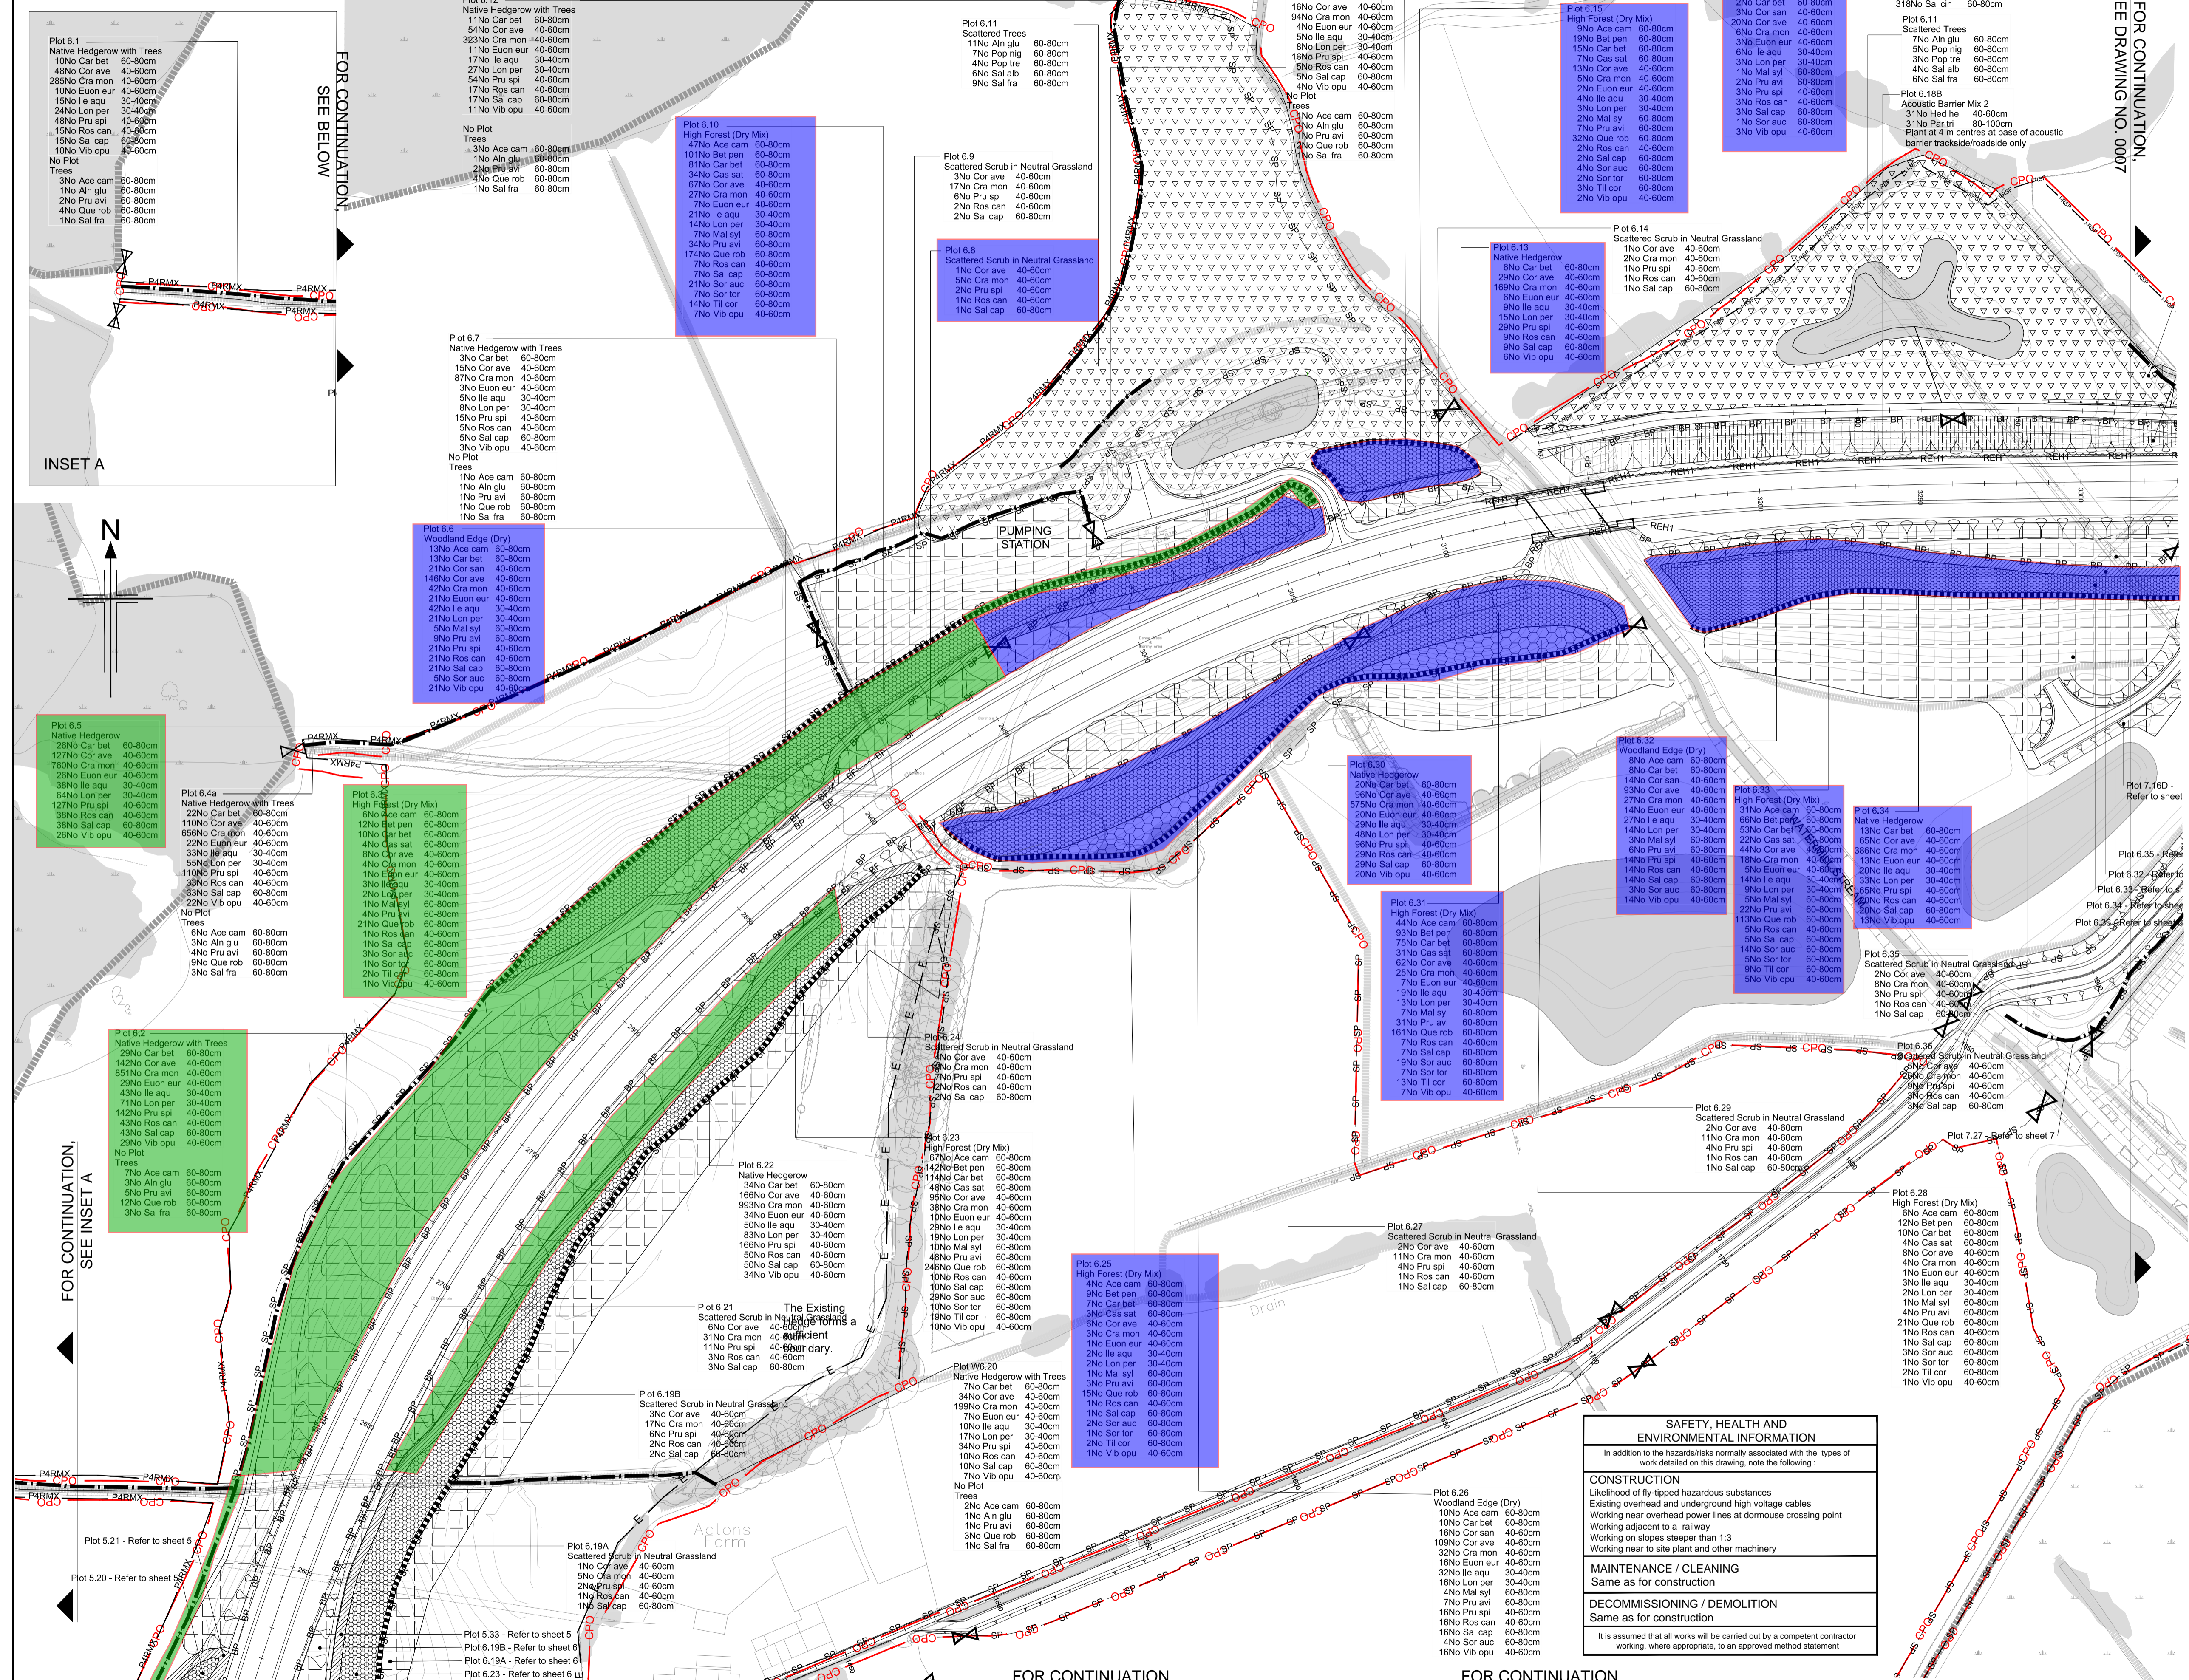

- NOTES**
- All dimensions in metres unless otherwise stated.
 - For complete fencing key, refer to fencing drawings.
- KEY**
- High Forest - Dry (Planting at 2m centres, random mix in groups of 3-5 of each species) (LE2.1 and LE2.4.1)
 - High Forest - Dry (Planting at 2.5m centres, random mix in groups of 3-5 of each species) (LE2.1 and LE2.4.1)
 - High Forest - Wet (Planting at 2m centres, random mix in groups of 3-5 of each species) (LE2.1 and LE2.4.1)
 - High Forest - Wet (Planting at 2.5m centres, random mix in groups of 3-5 of each species) (LE2.1 and LE2.4.1)
 - Dry Woodland Edge (3m wide, planting at approximately 1.2 - 1.5m centres in three staggered rows, random mix of 3-5 species (LE2.1 and LE2.4.1). Care must be taken not to plant in obvious or straight lines. Refer to planting spacing detail on drawing B1297000/3000.01a/0001)
 - Wet Woodland Edge (3m wide, planting at approximately 1.2 - 1.5m centres in three staggered rows, random mix of 3-5 species (LE2.1 and LE2.4.1). Care must be taken not to plant in obvious or straight lines. Refer to planting spacing detail on drawing B1297000/3000.01a/0001)
 - Scrub random mix in groups of 3 - 5 of each species (LE2.8)
 - Wetland Scrub random mix in groups of 3 - 5 of each species (LE2.8)
 - Existing Woodland to be managed (LE2.1.1)
 - Existing Woodland Edge to be Managed (LE2.2)
 - Scattered Trees in Wet Grassland, Marsh and Fen (LE6.4.1.1) Refer to planting spacing detail on drawing B1297000/3000.01a/0001
 - Scattered Scrub in Neutral Grassland (LE6.1.3.1) Refer to planting spacing detail on drawing B1297000/3000.01a/0001
 - Climbing plants on fences and structures - 4m linear spacing unless otherwise noted.
 - Woodland/woodland edge infill planting
 - Amenity Tree and Shrub Planting (LE3.1)
 - Extra heavy standard, semi-mature tree or multi-stem tree
 - Site of Special Scientific Interest (SSSI)
 - Site of Nature Conservation Importance (SNCI)
 - Native Species Hedgerows (LE4.3) Two staggered rows, planted at 0.5m centres, 0.5m between rows
 - Native Hedgerows with Trees (LE4.4) Two staggered rows, planted at 0.5m centres, 0.5m between rows. Trees shall be planted between rows at an average of 10m - 15m centres
 - Ditch
 - Watercourse
 - Pond
 - Public Footpath
 - Byway
 - Bridleway
 - Existing trees, hedges & scrub to be retained
 - Woodland management zones
 - CPO boundary

- BF BF - Bat Fence
- CB CB - 1.8m close boarded fence
- BP BP - 1.2m high timber post and wire fence with badger proofing (HCD/H13 + H46).
- P&R Timber post and four rail fence (HCD/H3)
- ABNB 1.8m high absorptive noise barrier
- REH1 1.8m high reflective Noise Barrier
- REH2 1.5m high reflective Noise Barrier

Rev	Rev. Date	Purpose of revision	Drawn	Checked	Rev'd	Appr'd
C3	04/11/2015	Planting revised to match scheme changes	AS	RM	RM	PDF
C2	11/08/2015	Plant Schedule Updated to Match Changes	CC	AS	TD	JP
C1	02/03/2015	Rev to match minor scheme layout changes	RM	AS	AB	JP
C0	28/07/2013	ISSUED FOR CONSTRUCTION	AS	RM	AB	JP

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Client: **HOCHTIEF** Employer: **TAYLOR WOODROW**

BEXHILL TO HASTINGS LINK ROAD

PLANTING SHEET 6 OF 14

Drawing status: **FOR CONSTRUCTION**

Scale: 1:1000 @ A1 **DO NOT SCALE**

Jacobs No. B1297000

Drawing number: **B1297000-PH2/3000.01a/0006** Rev **C3**

SAFETY, HEALTH AND ENVIRONMENTAL INFORMATION


In addition to the hazards/risks normally associated with the types of work detailed on this drawing, note the following:

CONSTRUCTION
Likelihood of fly-tipped hazardous substances
Existing overhead and underground high voltage cables
Working near overhead power lines at dormouse crossing point
Working adjacent to a railway
Working on slopes steeper than 1:3
Working near to site plant and other machinery

MAINTENANCE / CLEANING
Same as for construction

DECOMMISSIONING / DEMOLITION
Same as for construction

It is assumed that all works will be carried out by a competent contractor working, where appropriate, to an approved method statement

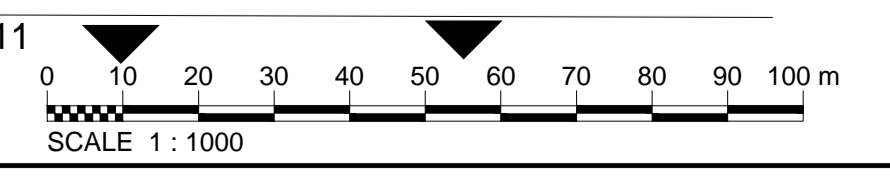

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P:\BTL\UOB\B1297000 Bexhill Hastings\Phase 2 - Detailer\Design\600 CAD\603 Drawings\3000 Landscape & Ecology

FOR CONTINUATION, SEE BELOW

INSET A

FOR CONTINUATION, SEE INSET A

FOR CONTINUATION, SEE DRAWING NO. 0005

FOR CONTINUATION, SEE DRAWING NO. 0011

FOR CONTINUATION, SEE DRAWING NO. 0007